


O1 EAST ELEVATION - DRUMMOND STREET Scale 1: 200 @ A3






O1 SCALE 1: 200 @ A3

Scale: 1:100 @A1 1:200 @A3		Client:	Architect:	Project Details:	Drawing Title:	Project Number:	Drawing Number:
11100 @/11 11200 @/10	I ISSUE TO COUNCIL (DA SUBMISSION)	HE 30.01.2025	LOUCAS ARCHITECTS	DECIDENTIAL DEVELOPMENT	ELEVATIONS OF	Dm 01010	A 2100
	H ISSUE TO CONSULTANTS	HE 17.05.2024 -		RESIDENTIAL DEVELOPMENT	ELEVATIONS 02	Pn-21010	A-2100
0 1 2 3 4 5	G ISSUE TO CLIENT	HE 12.04.2024	ABN 92 626 290 122				
	F ISSUE TO CLIENT	HE 27.02.2024	Level 3, Suite 309, 7-9 Gibbons St,	Project Address:		Drawing Status:	Issue:
	E ISSUE TO CLIENT	HE 31.08.2023	Redfern NSW, Australia	51 DRUMMOND STREET, BELMORE		AUTHORITY APPROVAL	
	D ISSUE TO CLIENT	HE 16.08.2023 Level 3, Suite 309, 7-9 Gibbons St,	Tel: (02) 8052 9600	,		AOTHORITATIOVAL	I
	C ISSUE TO CLIENT	HE 10.05.2023 Redfern NSW, Australia	Email: admin@loucasarc.com.au LOUCA	c			
Date Printed:	B ISSUE TO CLIENT	HE 28.01.2022 Tel: (02) 8052 9600	Nominated Architect:			PLOT GENERATED BY LOUCAS ARCHITECTS THIS DRAWING IS AN UNCONTRO	
14/03/2025	A ISSUE TO CLIENT	TL 09.07.2021 Email: admin@loucasarc.com.au	Jim Apostolou 7490 ARCHITECT			THIS DRAWING SHOULD BE READ IN CONJUNCTION WITH ALL RELEVAL DRAWINGS I COPYRIGHT OF THIS DRAWING IS VESTED IN LOUCAS ARCI	
	ISSUE REVISION DESCRIPTION	APP'D DATE				5	

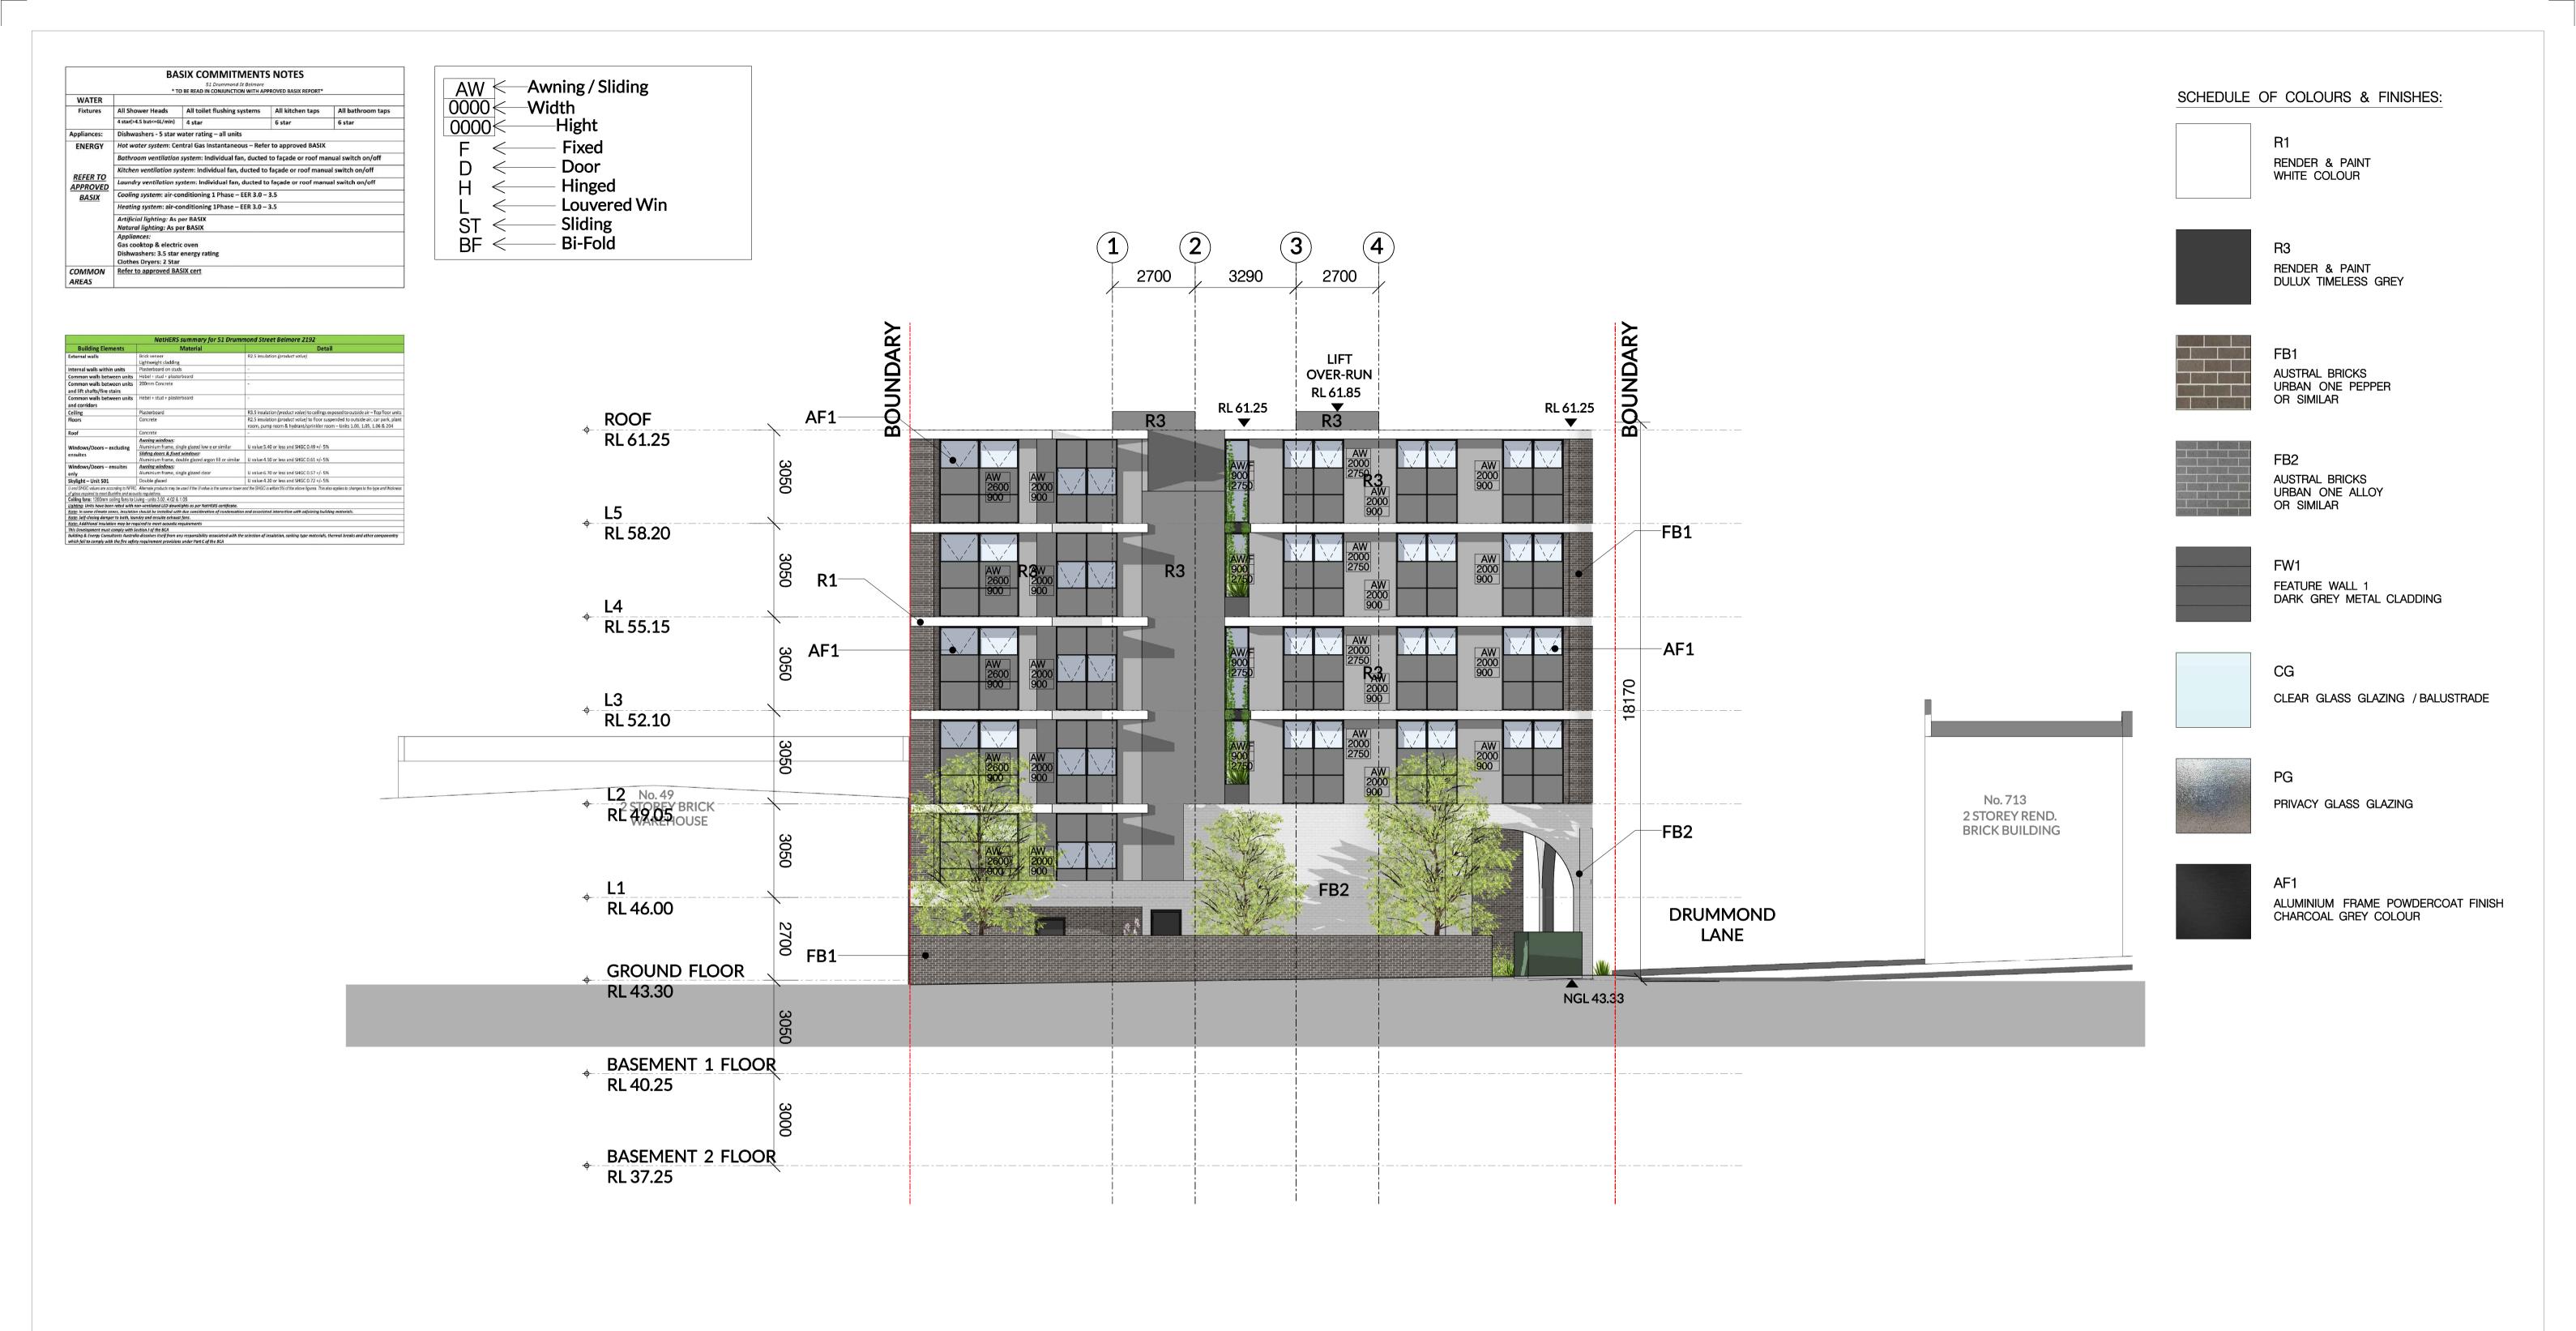



cale: 1:100 @A1 1:200 @A3				Client:	Architect:	Project Details:	Drawing Title:	Project Number:	Drawing Number:
77700 @711 71200 @710	I	ISSUE TO COUNCIL (DA SUBMISSION)	HE 30.01.2025		LOUCAS ARCHITECTS	DECIDENTIAL DEVELOPMENT	ELEVATIONS OF	Dm 21010	A-2200
0 1 2 3 4 5	Н	ISSUE TO CONSULTANTS	HE 17.05.2024	-	_	RESIDENTIAL DEVELOPMENT	ELEVATIONS 03	Pn-21010	A-2200
	G	ISSUE TO CLIENT	HE 12.04.2024		ABN 92 626 290 122				
	F	ISSUE TO CLIENT	HE 27.02.2024		Level 3, Suite 309, 7-9 Gibbons St,	Project Address:		Drawing Status:	Issue:
	E	ISSUE TO CLIENT	HE 31.08.2023	3	Redfern NSW, Australia	51 DRUMMOND STREET, BELMORE		AUTHORITY APPROVAL	
	D	ISSUE TO CLIENT	HE 16.08.2023	Level 3, Suite 309, 7-9 Gibbons St,	Tel: (02) 8052 9600	, in the second of the second		AOTHORITATIROVAL	l
	С	ISSUE TO CLIENT	HE 10.05.2023	Redfern NSW, Australia	Email: admin@loucasarc.com.au LOUCA				
ate Printed:	В	ISSUE TO CLIENT	HE 28.01.2022	Tel: (02) 8052 9600	Nominated Architect:			PLOT GENERATED BY LOUCAS ARCHITECTS THIS DRAWING IS AN UNCONTRO	S AN UNCONTROLLED COPY UNLESS STAMPED OTHERWIS L RELEVANT CONTRACTS, SPECIFICATION, REPORTS AND ICAS ABCHITECTS
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	ISSUE	REVISION DESCRIPTION	APP'D DATE						_

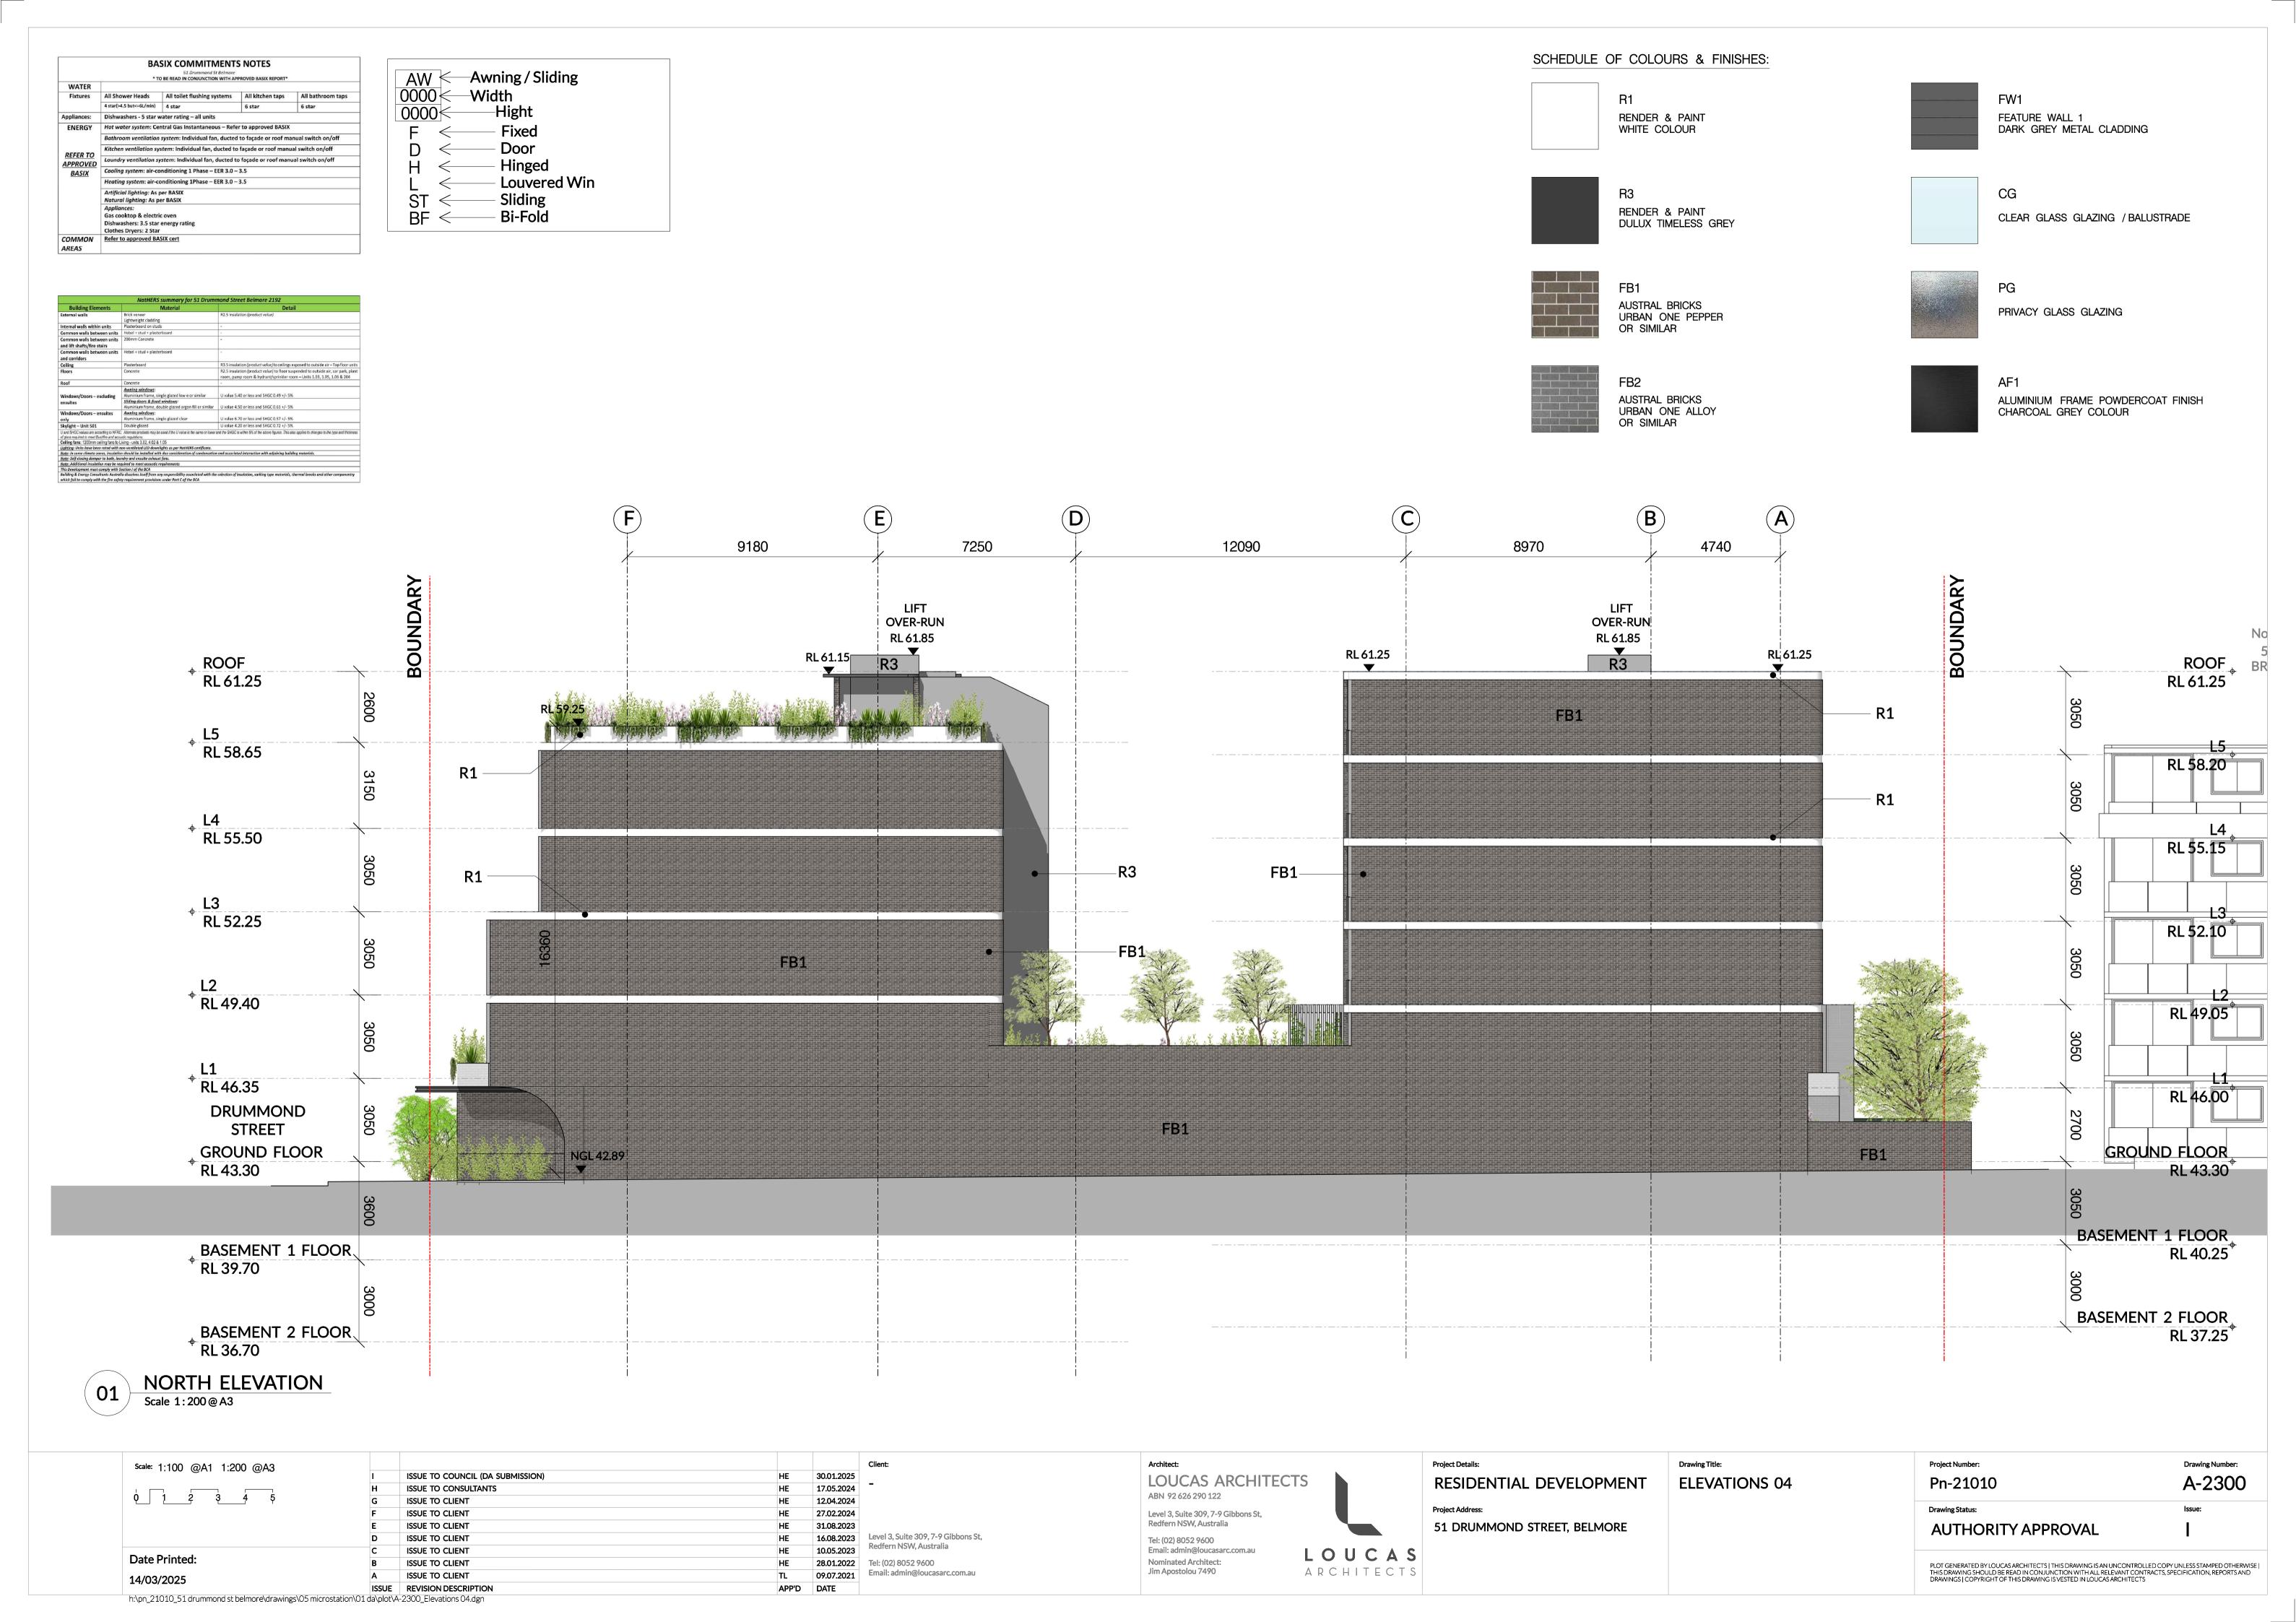

		SIX COMMITMENTS 51 Drummond St Belmare D BE READ IN CONJUNCTION WITH AP				_ _
WATER		DE HERO III GOINGHEILON WITH	THO YES SHOWN THE OWN		HVV	┦`
Fixtures	All Shower Heads	All toilet flushing systems	All kitchen taps	All bathroom taps	0000	₭
	4 star(>4.5 but<=6L/min)	4 star	6 star	6 star	0000	
Appliances:	Dishwashers - 5 star w	vater rating – all units			0000	↖
ENERGY	Hot water system: Cer	ntral Gas Instantaneous – Refe	r to approved BASIX			_
	Bathroom ventilation					
DEFEN TO	Kitchen ventilation sys	D	\leq			
REFER TO APPROVED	Laundry ventilation sy	stem: Individual fan, ducted to	o façade or roof man	ual switch on/off		
BASIX	Cooling system: air-co					
	Heating system: air-co		\leq			
	Artificial lighting: As p	L ST	$\stackrel{ ightharpoonup}{<}$			
	Appliances: Gas cooktop & electric		_			
	Dishwashers: 3.5 star Clothes Dryers: 2 Star	energy rating			БГ	_
COMMON AREAS	Refer to approved BAS	SIX cert				

	NatHERS summary for 51 Drumi	mond Street Belmore 2192
Building Elements	Material	Detail
External walls	Brick veneer Lightweight cladding	R2.5 insulation (product value)
Internal walls within units	Plasterboard on studs	
Common walls between units	Hebel + stud + plasterboard	
Common walls between units and lift shafts/fire stairs	200mm Concrete	•
Common walls between units and corridors	Hebel + stud + plasterboard	-
Ceiling	Plasterboard	R3.5 insulation (product value) to ceilings exposed to outside air - Top floor units
Floors	Concrete	R2.5 insulation (product value) to floor suspended to outside air, car park, plant room, pump room & hydrant/sprinkler room – Units 1.03, 1.05, 1.06 & 204
Roof	Concrete	
	Awning windows:	
Windows/Doors – excluding	Aluminium frame, single glazed low e or similar	U value 5.40 or less and SHGC 0.49 +/- 5%
ensuites	Sliding doors & fixed windows: Aluminium frame, double glazed argon fill or similar	U value 4.50 or less and SHGC 0.61 +/- 5%
Windows/Doors – ensuites only	Awning windows: Aluminium frame, single glazed clear	U value 6.70 or less and SHGC 0.57 +/- 5%
Skylight – Unit 501	Double glazed	U value 4.20 or less and SHGC 0.72 +/- 5%
of glass required to meet Bushfire and accu	istic regulations.	and the SHGC is within 5% of the above figures. This also applies to changes to the type and thickness
Ceiling fans: 1200mm ceiling fans to L	iving - units 3.02, 4.02 & 1.05 ion-ventilated LED downlights as per NatHERS certificate.	
		and associated interaction with adjoining building materials.
Note: Self-closing damper to bath, lau		Tana associated interaction with abjoining building materials.
Note: Additional insulation may be rec		
This Development must comply with S		

AW	-Awning/Sliding	
0000 ←	–Width	
0000	Hight	
F ←	—— Fixed	
$D \leftarrow$	—— Door	
$H \leftarrow$	Hinged	
$L \leftarrow$	Louvered Win	
$ST \leftarrow$	—— Sliding	
$BF \leftarrow$	—— Bi-Fold	

					AUSTRAL BRICKS URBAN ONE PEPPER OR SIMILAR
	BOUNDARY	1 2 3 2700 3290 LIFT OVER-RUN RL 61.85	2700	>	FB2 AUSTRAL BRICKS URBAN ONE ALLOY OR SIMILAR
ROOF RL 61.25	A				
RL 61.25 SS E5 RL 58.20	Y Y Y Y Y Y Y Y Y Y	ST 5430 2750 2750 ->	ST 2370 2750 2750 ->		
L4 RL 55.15	The second sec	ST ST 2480 2750 ->	ST 2370 2750 -> ST 2900 2750 ->		
RL 55.15 GC CC RL 52.10	## A man and a m	ST ST 2480 2750 ->	ST 2370 2750 2750 >>		
RL 52.10 0508 L2	The state of the s	ST ST 2480 2750 →	ST 2370 2750 2750 →		
RL 49.05			A Committee of the Comm		
090E L1		ST 2100 2750 ←	ST 4000 2750 >		
GROUND FLOOR					
GROUND FLOOR RL 43.30					
3050					
BASEMENT 1 FLOOR RL 40.25					
3000					

SCHEDULE OF COLOURS & FINISHES:

R1 RENDER & PAINT WHITE COLOUR



FW1
FEATURE WALL 1
DARK GREY METAL CLADDING



R3 RENDER & PAINT DULUX TIMELESS GREY



CG

CLEAR GLASS GLAZING / BALUSTRADE



PG

PRIVACY GLASS GLAZING




AF1

ALUMINIUM FRAME POWDERCOAT FINISH CHARCOAL GREY COLOUR

01 INTERNAL WEST ELEVATION Scale 1:200@A3

≈ 1:100 @A1 1:200 @A3			Client:	Architect:	Project Details:	Drawing Title:	Project Number:	Drawing Number:
11100 @711 11200 @710	I ISSUE TO COUNCIL (DA SUBMISSION)	HE 30.01.2025		LOUCAS ARCHITECTS	DECIDENTIAL DEVELOPMENT	ELEVATIONS OF	Dm 24040	A 2250
0 1 2 3 4 5	H ISSUE TO CONSULTANTS	HE 17.05.2024		RESIDENTIAL DEVELOPMENT	ELEVATIONS 05	Pn-21010	A-2350	
	G ISSUE TO CLIENT	HE 12.04.2024		ABN 92 626 290 122				
	F ISSUE TO CLIENT	HE 27.02.2024		Level 3, Suite 309, 7-9 Gibbons St,	Project Address:		Drawing Status:	Issue:
	E ISSUE TO CLIENT	HE 31.08.2023		Redfern NSW, Australia	51 DRUMMOND STREET, BELMORE		AUTHORITY APPROVAL	1
	D ISSUE TO CLIENT	HE 16.08.2023		Tel: (02) 8052 9600	,		AOTHORITATIROVAL	I
	C ISSUE TO CLIENT	HE 10.05.2023	Redfern NSW, Australia	Email: admin@loucasarc.com.au LOUCA	c			
Printed:	B ISSUE TO CLIENT	HE 28.01.2022		Nominated Architect:			PLOT GENERATED BY LOUCAS ARCHITECTS LTHIS DRAWING IS AN UNCONTROLLED COPY UNLESS STAMPI	
14/03/2025	A ISSUE TO CLIENT	TL 09.07.2021		Jim Apostolou 7490 ARCHITECT	\$		THIS DRAWING SHOULD BE READ IN CONJUNCTION WITH ALL RELEVANT CO DRAWINGS I COPYRIGHT OF THIS DRAWING IS VESTED IN LOUCAS ARCHITEC	
	ISSUE REVISION DESCRIPTION	APP'D DATE					2	

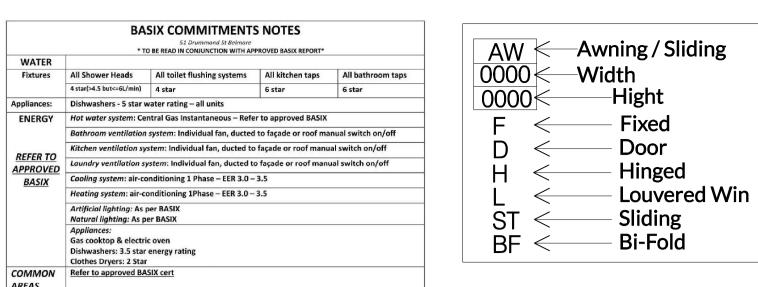

Building Elements	Material	Detail
External walls	Brick veneer	R2.5 insulation (product value)
	Lightweight cladding	
Internal walls within units	Plasterboard on studs	
Common walls between units	Hebel + stud + plasterboard	
Common walls between units and lift shafts/fire stairs	200mm Concrete	•
Common walls between units and corridors	Hebel + stud + plasterboard	9
Ceiling	Plasterboard	R3.5 insulation (product value) to ceilings exposed to outside air - Top floor unit
Floors	Concrete	R2.5 insulation (product value) to floor suspended to outside air, car park, plan room, pump room & hydrant/sprinkler room – Units 1.03, 1.05, 1.06 & 204
Roof	Concrete	
	Awning windows:	
Windows/Doors - excluding	Aluminium frame, single glazed low e or similar	U value 5.40 or less and SHGC 0.49 +/- 5%
ensuites	Sliding doors & fixed windows: Aluminium frame, double glazed argon fill or similar	U value 4.50 or less and SHGC 0.61 +/- 5%
Windows/Doors – ensuites	Awning windows:	
only	Aluminium frame, single glazed clear	U value 6.70 or less and SHGC 0.57 +/- 5%
Skylight – Unit 501	Double glazed	U value 4.20 or less and SHGC 0.72 +/- 5%
U and SHGC values are according to NFRC of glass required to meet Bushfire and accur	istic regulations.	and the SHGC is within 5% of the above figures. This also applies to changes to the type and thicknes
Ceiling fans: 1200mm ceiling fans to L		
	on-ventilated LED downlights as per NatHERS certificate.	
Note: In some climate zones, insulatio Note: Self-closing damper to bath, lau		and associated interaction with adjoining building materials.
Note: Additional insulation may be rec		
This Development must comply with S		



SCHEDULE OF COLOURS & FINISHES:

FW1

CG

PG

FEATURE WALL 1

DARK GREY METAL CLADDING

PRIVACY GLASS GLAZING

CHARCOAL GREY COLOUR

CLEAR GLASS GLAZING / BALUSTRADE

ALUMINIUM FRAME POWDERCOAT FINISH

01 INTERNAL EAST ELEVATION Scale 1:200@A3

BASEMENT 2 FLOOR RL 36.70

e: 1:100 @A1 1:200 @A3			Client:	Architect:	Project Details:	Drawing Title:	Project Number:	Drawing Number:
11100 (6711 11200 (6710	I ISSUE TO COUNCIL (DA SUBMISSION)	HE 30.01.2025		LOUCAS ARCHITECTS	DECIDENTIAL DEVELOPMENT	ELEVATIONE OF	Dm 01010	A 2240
0 1 2 3 4 5	H ISSUE TO CONSULTANTS	HE 17.05.2024		RESIDENTIAL DEVELOPMENT	ELEVATIONS 06	Pn-21010	A-2360	
	G ISSUE TO CLIENT	HE 12.04.2024		ABN 92 626 290 122				
	F ISSUE TO CLIENT	HE 27.02.2024		Level 3, Suite 309, 7-9 Gibbons St,	Project Address:		Drawing Status:	Issue:
	E ISSUE TO CLIENT	HE 31.08.2023		Redfern NSW, Australia	51 DRUMMOND STREET, BELMORE		AUTHORITY APPROVAL	
	D ISSUE TO CLIENT	HE 16.08.2023		Tel: (02) 8052 9600			AOTHORITTALLROVAL	
	C ISSUE TO CLIENT	HE 10.05.2023	Redfern NSW, Australia	Email: admin@loucasarc.com.au LOUCA	c			
Printed:	B ISSUE TO CLIENT	HE 28.01.2022	Tel: (02) 8052 9600	Nominated Architect:			PLOT GENERATED BY LOUCAS ARCHITECTS LTHIS DRAWING IS AN UNCONTROLLED COPY UNLESS STAN	
14/03/2025	A ISSUE TO CLIENT	TL 09.07.2021	1 Email: admin@loucasarc.com.au	Jim Apostolou 7490 ARCHITECT	S		THIS DRAWING SHOULD BE READ IN CONJUNCTION WITH ALL RELEVANT CO DRAWINGS I COPYRIGHT OF THIS DRAWING IS VESTED IN LOUCAS ARCHITEC	
	ISSUE REVISION DESCRIPTION	APP'D DATE					DIVINIOS POST MONTO PRINCIPLO DE PESTED IN 2000 D'ANGINEZO	



O1 STREETSCAPE ELEVATION - DRUMMOND STREET
Scale 1:200@A3

Scale: 1:100 @A1 1:200 @A3		Client:	Architect:	Project Details:	Drawing Title:	Project Number:	Drawing Number:
1.100 @/11 1.200 @/10	I ISSUE TO COUNCIL (DA SUBMISSION)	HE 30.01.2025	LOUCAS ARCHITECTS	DECIDENTIAL DEVELOPMENT	CTDEETCC ADE ELEVATION	D= 24040	A 240
0 1 2 3 4 5	H ISSUE TO CONSULTANTS	HE 17.05.2024		RESIDENTIAL DEVELOPMENT	STREETSCAPE ELEVATION	Pn-21010	A-240
	G ISSUE TO CLIENT	HE 12.04.2024	ABN 92 626 290 122				
	F ISSUE TO CLIENT	HE 27.02.2024	Level 3, Suite 309, 7-9 Gibbons St,	Project Address:		Drawing Status:	Issue:
	E ISSUE TO CLIENT	HE 31.08.2023	Redfern NSW, Australia	51 DRUMMOND STREET, BELMORE		AUTHORITY APPROVAL	ı
	D ISSUE TO CLIENT	HE 16.08.2023 Level 3, Suite 309, 7-9 Gibbons St,	Tel: (02) 8052 9600			AOTHORITTATTROVAL	I
	C ISSUE TO CLIENT HE 10.05.2023 Redfern NSW, Australia	HE 10.05.2023 Redfern NSW, Australia	Email: admin@loucasarc.com.au LOUCAS	c			
Date Printed:	B ISSUE TO CLIENT	HE 28.01.2022 Tel: (02) 8052 9600	Nominated Architect:			PLOT GENERATED BY LOUCAS ARCHITECTS THIS DRAWING IS AN UNCONTROLLE	
14/03/2025	A ISSUE TO CLIENT	TL 09.07.2021 Email: admin@loucasarc.com.au	Jim Apostolou 7490 ARCHITECT	S		THIS DRAWING SHOULD BE READ IN CONJUNCTION WITH ALL RELEVANT CONTR DRAWINGS I COPYRIGHT OF THIS DRAWING IS VESTED IN LOUCAS ARCHITECTS	FRACTS, SPECIFICATION, REPO
	ISSUE REVISION DESCRIPTION	APP'D DATE				SWAMMON CONTROL OF THIS SWAMMON VESTED IN ESCONDANCINITECTS	